TOWN OF LEICESTER AGENDA PLANNING BOARD MONDAY November 29, 2021 6:00P.M.

OPEN MEETING 6:00 P.M.
PLEDGE TO THE FLAG:
MINUTES: October 18, 2021:
Deem if Application is Complete:
Seneca Foods Site Plan Review:
A Motion to send to County Planning Board for Review: 1st: 2nd:
Motion Carried or Motion Denied Ayes: Noes:
A Motion to Set Public Hearing for Seneca on December 13, 2021, at 6:pm 1 st : 2 nd :
Motion Carried or Motion Denied Ayes: Noes:
COMMENTS OR CONCERNS FROM PUBLIC OR PLANNING BOARD:
ADJOURN:



October 28, 2021

Planning Board Town of Leicester 132 Main Street Leicester, NY 14481

Re: Seneca Foods Corporation Site Plan Review

5705 Route 36, Leicester Tax Account No. 97.00-01-33.1

Dear Board Members:

On behalf of Seneca Foods Corporation, we are requesting Site Plan review for a new $\pm 4,460$ sf residential building as an accessory use to the plant. We have included the following application materials for your use in review of the application:

- Site Plans
- Application for Review and Approval of Site Plan
- Building Elevations and Floor Plans
- Ag Data Statement and Tax Map
- Short Form EAF
- \$25.00 Application Fee

The Seneca Foods Corporation facility is located at 5705 Route 36 and within the Industrial (I) zoning district. The property currently has accessory housing units on the property that support the plant operations. Seneca Foods is proposing to construct a new $\pm 4,460$ sf one-story building and extending a new public water and sanitary sewer to serve the new buildings(s). The building will include sprinklers and be master metered and backflow protected. In anticipation for their growing operations, we are also requesting approval for a future $\pm 4,460$ sf building one-story residential building, which would be similar to the one proposed.

We understand the Town Board will need to review the Industrial Zoning District Code Section 609(C) to allow residential as a permitted accessory use within the zoning district. However, we would like to keep the communication and process moving forward so we can try to accommodate Seneca Foods schedule for operations next year.

Please review and contact our office if you require any additional information prior to the meeting.


Sincerely,

BME ASSOCIATES

Lincoln Swedrock, P.E.


Encl.

c: Max Heagney; LeFrois Builders Ryan Schuyler; Seneca Foods Gary Hadyk; Seneca Foods 2794

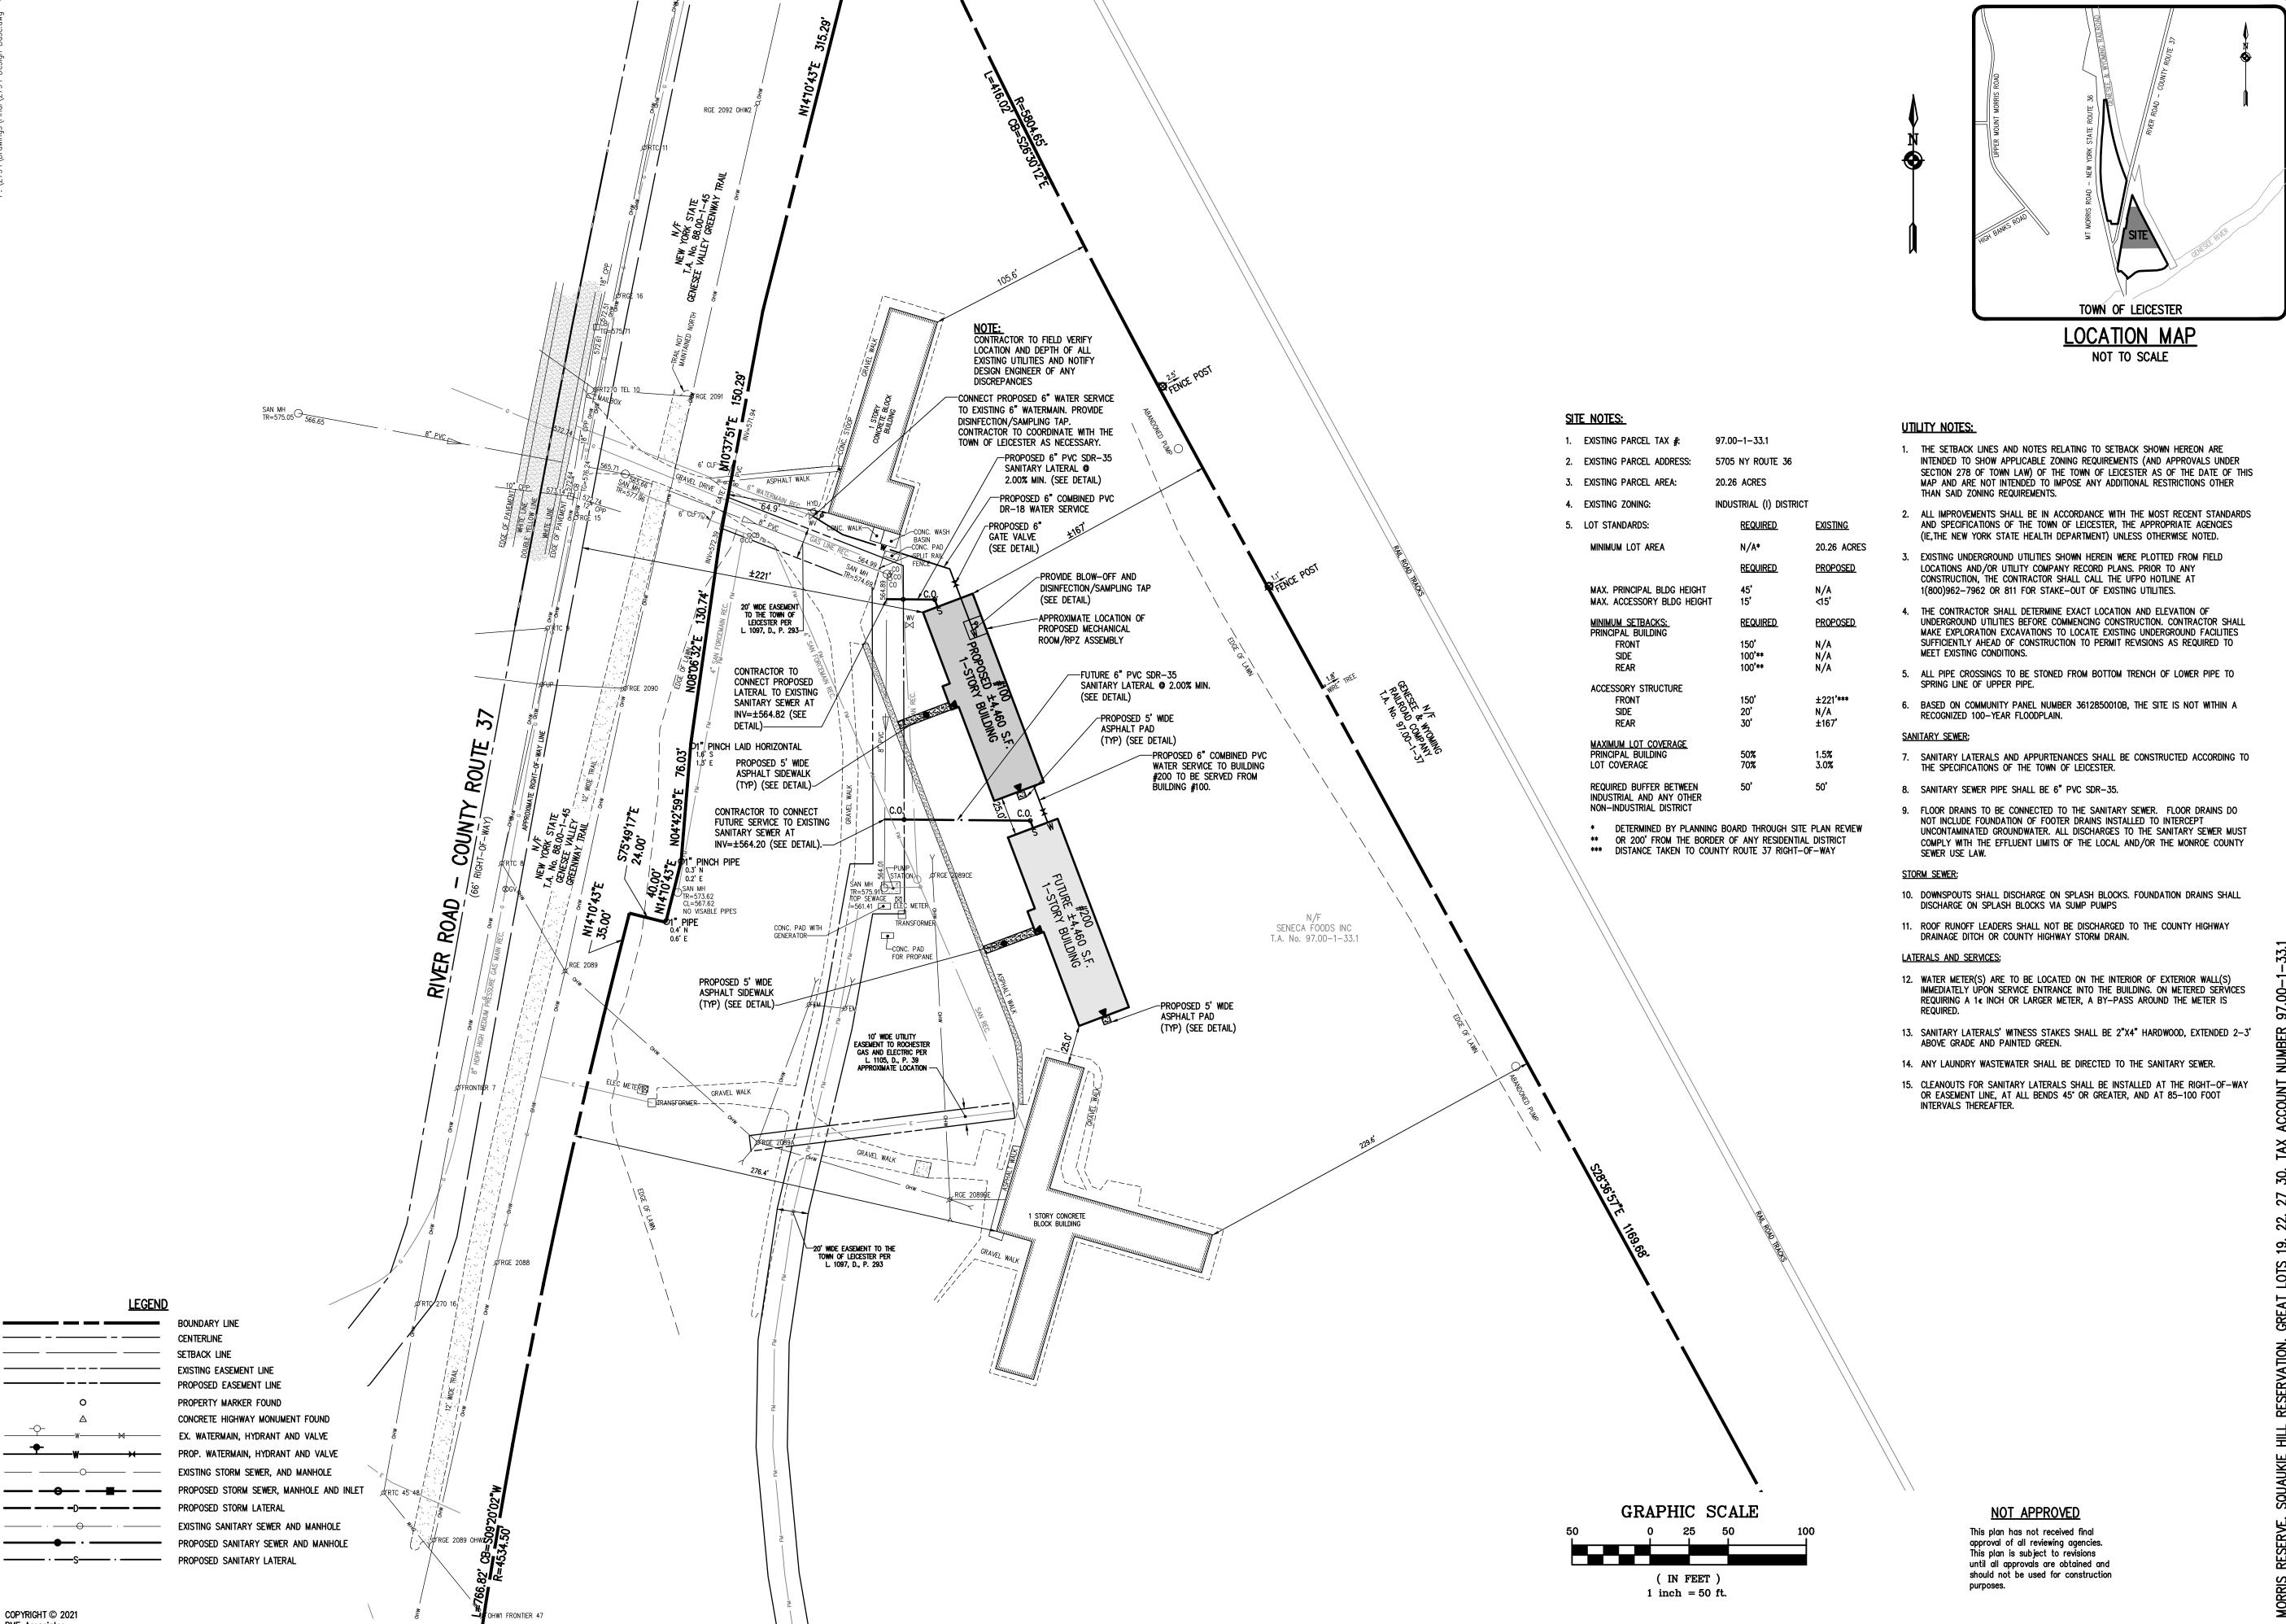

The following is an excerpt from the New York State Education Law Article 145 Section 7209 and applies to this

person, unless he is acting under the direction of a licensed professional engineer or land surveyor to alter any item in any way. If an item bearing the seal of an engineer or land surveyor is altered, the altering engineer or land surveyor shall affix to the item his seal and the notation "altered by" followed by his signature and the date of such

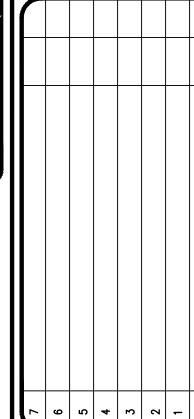


S



PROJECT MANAGER JL SWEDROCK PROJECT ENGINEER JL SWEDROCK DRAWN BY M SERENI SCALE DATE ISSUED 1"=50' PROJECT NO.

DRAWING NO.

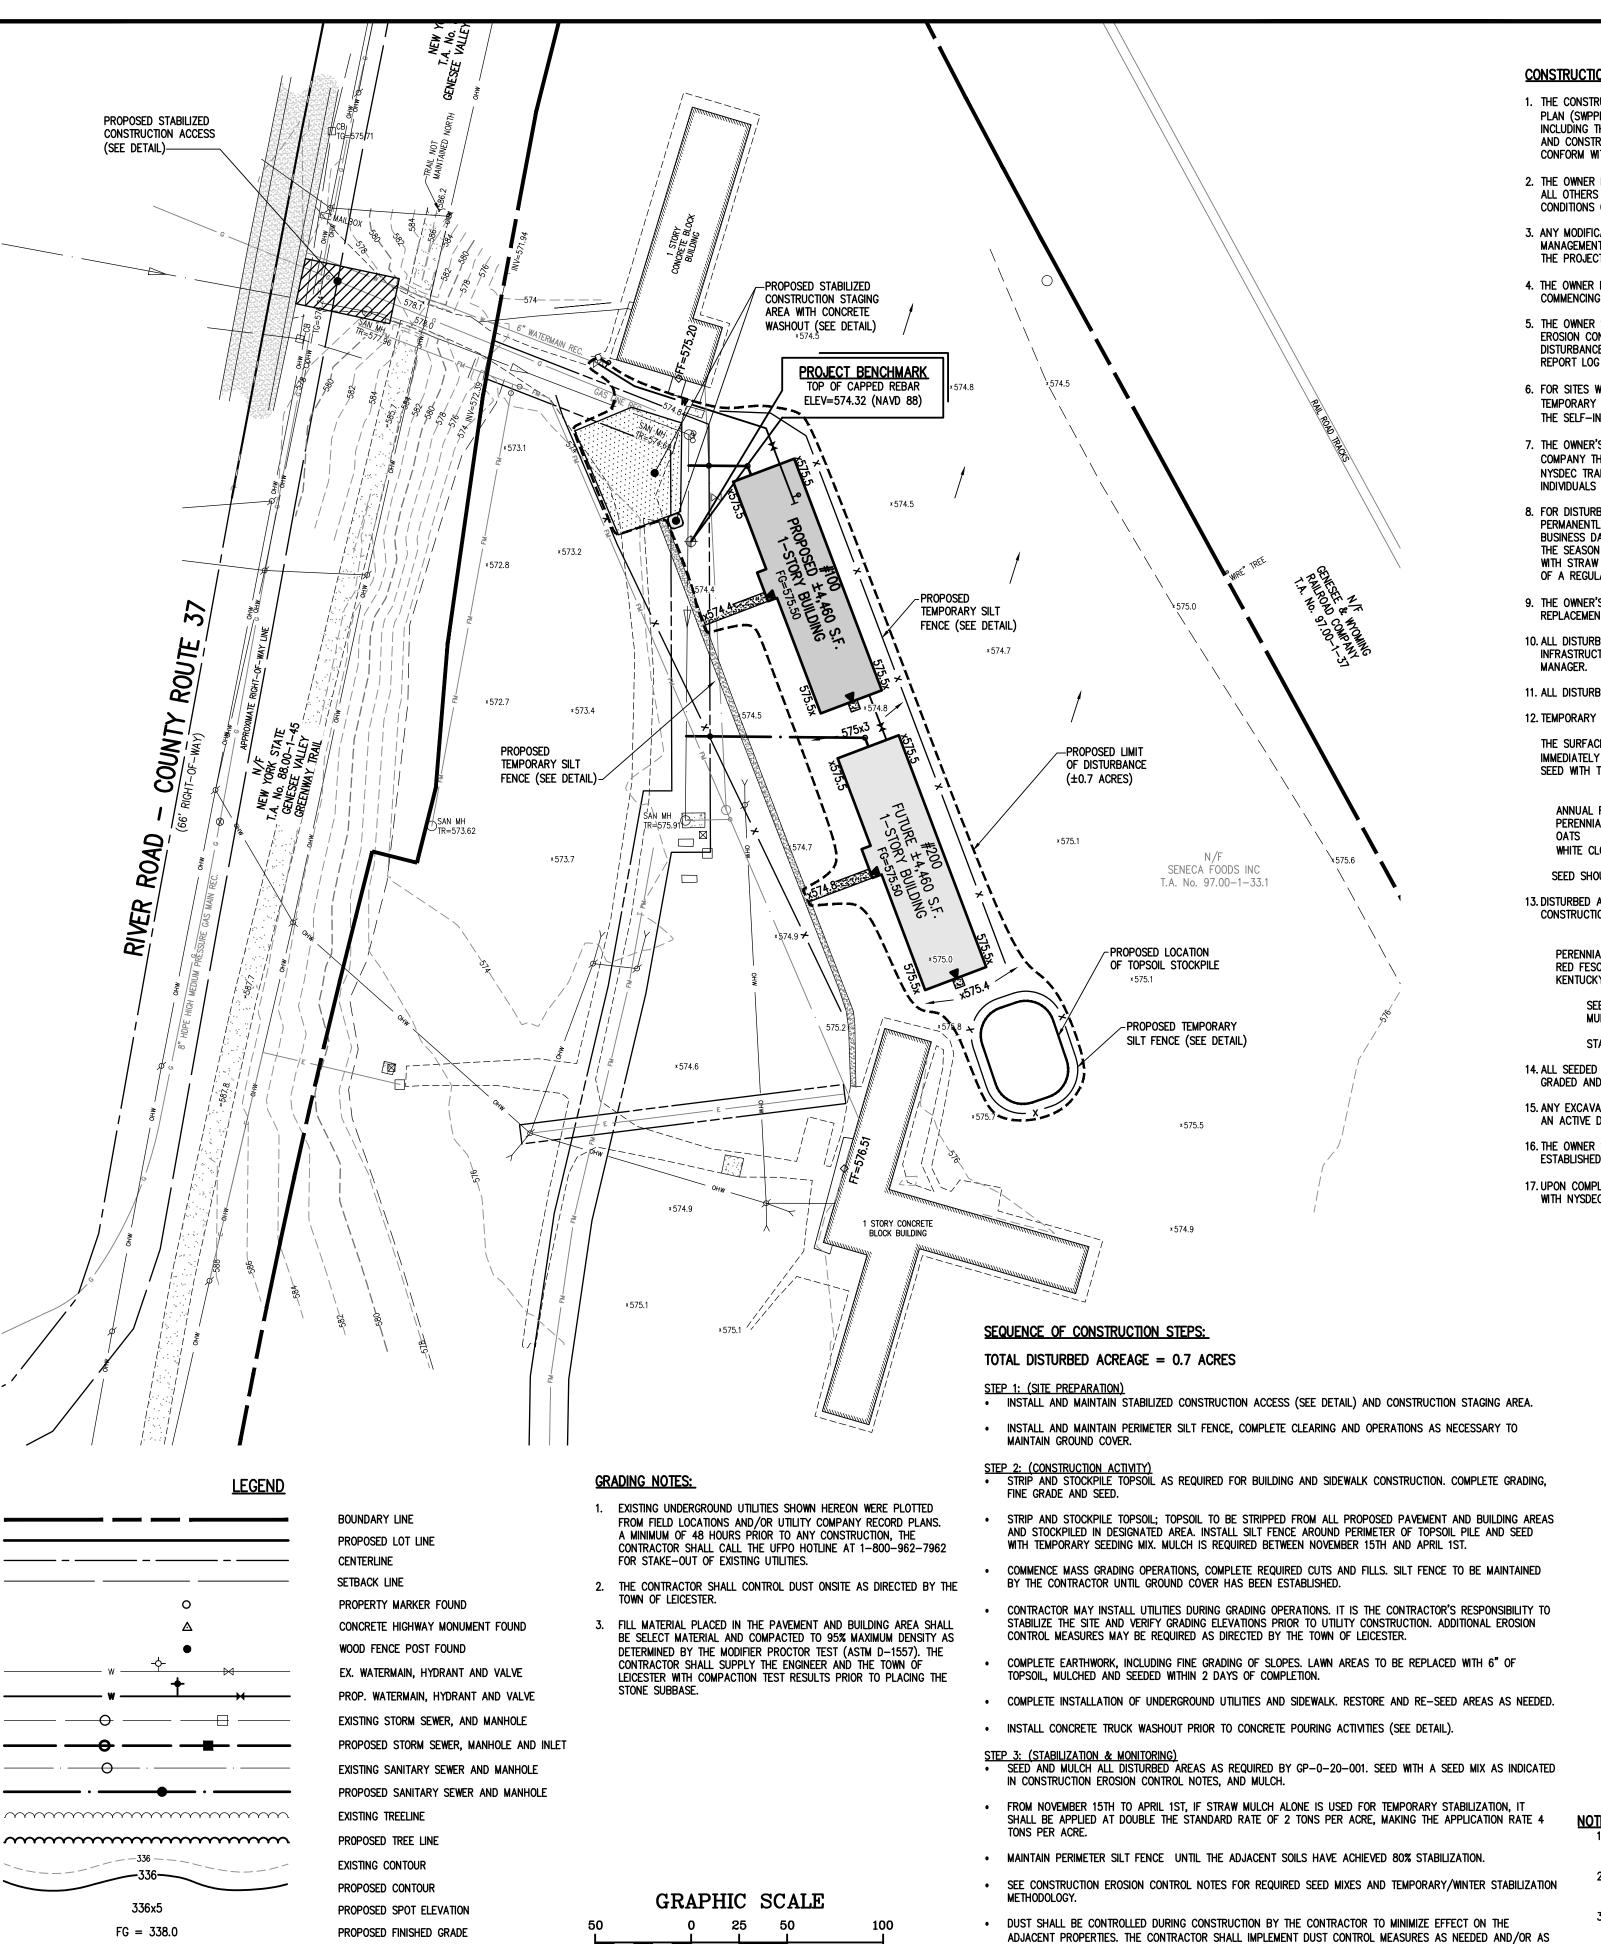

(IN FEET

1 inch = 50 ft.

PROPOSED SILT FENCE

COPYRIGHT © 2021

DIRECTED BY THE TOWN ENGINEER OR OWNER.


BY THE OWNER OR TOWN OF LEICESTER.

THE CONTRACTOR SHALL BE RESPONSIBLE FOR KEEPING THE EXISTING ROADWAYS, PAVED AREAS, AND CHANNELS


FREE OF MUD, DIRT, AND DEBRIS. THE CONTRACTOR WILL CLEAN THESE AREAS AS NECESSARY OR AS REQUIRED

CONSTRUCTION EROSION CONTROL NOTES:


- 1. THE CONSTRUCTION ACTIVITIES FOR THIS PROJECT REQUIRE THE PREPARATION OF A STORMWATER POLLUTION PREVENTION PLAN (SWPPP) THAT ONLY INCLUDES EROSION & SEDIMENT CONTROLS. THIS SWPPP CONSISTS OF THE PROJECT PLANS, INCLUDING THE GRADING, CONSTRUCTION EROSION CONTROL PLAN AND DETAIL SHEET, AND THE TOWN OF LEICESTER DESIGN AND CONSTRUCTION SPECIFICATIONS REGARDING STORMWATER CONTROL. THE PLANS FOR THIS PROJECT ARE INTENDED TO CONFORM WITH THE NYSDEC GENERAL PERMIT GP-0-20-001 AND THE REQUIREMENTS OF LOCAL AND NYSDEC AUTHORITIES.
- 2. THE OWNER IS RESPONSIBLE FOR IMPLEMENTING THE REQUIRED SWPPP. THE OWNER'S CONTRACTOR, SUB-CONTRACTOR AND ALL OTHERS ASSOCIATED WITH THE IMPLEMENTATION OF THE PLAN SHALL BE FAMILIAR WITH THE PLAN AND THE CONDITIONS OF THE NYSDEC GENERAL PERMIT FOR STORMWATER DISCHARGES FROM CONSTRUCTION ACTIVITIES.
- 3. ANY MODIFICATIONS OR DEVIATIONS FROM THE SWPPP, INCLUDING EROSION CONTROL MEASURES AND STORMWATER MANAGEMENT FACILITIES, SHALL BE DOCUMENTED IN THE INSPECTION REPORT AND CONSIDERED PART OF THE SWPPP FOR
- 4. THE OWNER IS RESPONSIBLE FOR FILING THE NOTICE OF INTENT (NOI) FOR CONSTRUCTION ACTIVITY WITH NYSDEC PRIOR TO COMMENCING ANY CONSTRUCTION. A COPY OF THE NOI SHALL BE KEPT ON-SITE AND PROVIDED TO THE MUNICIPALITY.
- 5. THE OWNER SHALL BE RESPONSIBLE FOR PROVIDING ON SITE INSPECTIONS BY A LICENSED PROFESSIONAL REGARDING EROSION CONTROL DURING CONSTRUCTION. INSPECTIONS ARE TO BE PROVIDED AT A MINIMUM OF TWICE A WEEK FOR DISTURBANCES OF 5 ACRES AND GREATER AND ONCE A WEEK FOR DISTURBANCES LESS THAN 5 ACRES. AN INSPECTION REPORT LOG AND THE SWPPP ARE TO BE KEPT ON-SITE BY THE OWNER.
- 6. FOR SITES WHERE SOIL DISTURBANCE ACTIVITIES HAVE BEEN TEMPORARILY SUSPENDED (E.G. WINTER SHUTDOWN) AND TEMPORARY STABILIZATION MEASURES HAVE BEEN APPLIED TO ALL DISTURBED AREAS, THE OWNER/OPERATOR MAY REDUCE THE SELF-INSPECTION FREQUENCY, BUT SHALL MAINTAIN A MINIMUM OF MONTHLY INSPECTIONS. (30 CALENDAR DAYS)
- 7. THE OWNER'S CONTRACTOR/REPRESENTATIVE SHALL IDENTIFY AT LEAST ONE INDIVIDUAL TO BE TRAINED FROM THEIR COMPANY THAT WILL BE RESPONSIBLE FOR IMPLEMENTATION OF THE SWPPP. THE INDIVIDUAL MUST RECEIVE (4) HOURS OF NYSDEC TRAINING EVERY (3) YEARS. THE OWNER/OPERATOR SHALL ENSURE THAT AT LEAST ONE OF THE TRAINED INDIVIDUALS IS ON SITE ON A DAILY BASIS WHEN SOIL DISTURBANCE ACTIVITIES ARE BEING PERFORMED.
- 8. FOR DISTURBANCES LESS THAN 5 ACRES, IN AREAS WHERE SOIL DISTURBANCE ACTIVITY HAS TEMPORARILY OR PERMANENTLY CEASED, THE APPLICATION OF SOIL STABILIZATION MEASURES MUST BE INITIATED BY THE END OF THE NEXT BUSINESS DAY AND COMPLETED WITHIN 14 DAYS. FROM THE DATE THE CURRENT SOIL DISTURBANCE ACTIVITY CEASED. IF THE SEASON PREVENTS THE ESTABLISHMENT OF TEMPORARY GROUNDCOVER, THE DISTURBED AREAS SHALL BE MULCHED WITH STRAW OR EQUIVALENT MATERIAL. ADDITIONAL TIME FRAMES FOR STABILIZATION ARE SUBJECT TO THE REQUIREMENTS OF A REGULATED TRADITIONAL LAND USE MS4.
- 9. THE OWNER'S CONTRACTOR SHALL BE RESPONSIBLE FOR THE ESTABLISHMENT, MAINTENANCE, CLEANING, REPAIR AND REPLACEMENT OF EROSION CONTROL MEASURES DURING SITE CONSTRUCTION.
- 10. ALL DISTURBED AREAS TO BE RESTORED PER TABLE 5.3 SOIL RESTORATION REQUIREMENTS FOUND IN CHAPTER 5: GREEN INFRASTRUCTURE PRACTICES OF THE NYS STORMWATER MANAGEMENT DESIGN MANUAL. PLEASE REVIEW WITH PROJECT
- 11. ALL DISTURBED AREAS TO BE RECLAIMED WITH A MINIMUM OF 6" TOPSOIL.
- 12. TEMPORARY SEEDING OF DISTURBED AREAS SHALL BE PROVIDED AS FOLLOWS:
- THE SURFACE TWO INCHES OF SOIL SHOULD BE LOOSENED BY DISKING, RAKING, OR BACK-BLADING WITH A BULLDOZER. IMMEDIATELY FERTILIZE WITH 300 LBS PER ACRE (OR 7 LBS. PER 1000 SQ. FT.) OF 10-10-10 FERTILIZER. IMMEDIATELY SEED WITH THE FOLLOWING MIX:

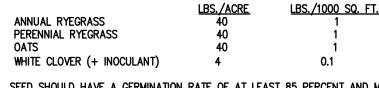

- SEED SHOULD HAVE A GERMINATION RATE OF AT LEAST 85 PERCENT AND MINIMAL INERT MATERIAL.
- 13. DISTURBED AREAS SHALL BE STABILIZED USING PERMANENT LAWN SEEDING MIX UPON COMPLETION OF GRADING AND CONSTRUCTION:

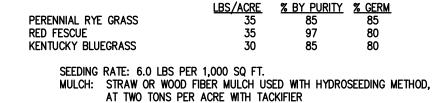


- STARTING FERTILIZER: 5-10-10 AT 20 LBS PER 1,000 SQ. FT 14. ALL SEEDED AREAS ARE TO BE MONITORED FOR GERMINATION AND EROSION. ERODED AREAS ARE TO BE BACKFILLED, FINE GRADED AND RE-SEEDED. AREAS THAT FAIL TO GERMINATE A MINIMUM OF 80% SHALL BE RE-SEEDED.
- 15. ANY EXCAVATIONS THAT MUST BE DEWATERED SHALL BE PUMPED INTO AN APPROVED FILTERING DEVICE BEFORE ENTERING AN ACTIVE DRAINAGE SYSTEM OR DISPERSED TO AN UNDISTURBED AREA.
- 16. THE OWNER SHALL BE RESPONSIBLE FOR REMOVING EXISTING EROSION CONTROL MEASURES THAT ARE LOCATED WITHIN ESTABLISHED AREAS. MATERIALS ARE TO BE DISPOSED OF PROPERLY.
- 17. UPON COMPLETION OF CONSTRUCTION AND FINAL STABILIZATION THE OWNER MAY FILE A NOTICE OF TERMINATION (NOT) WITH NYSDEC PER THE REQUIREMENTS OF THE GENERAL PERMIT GP-0-20-001.

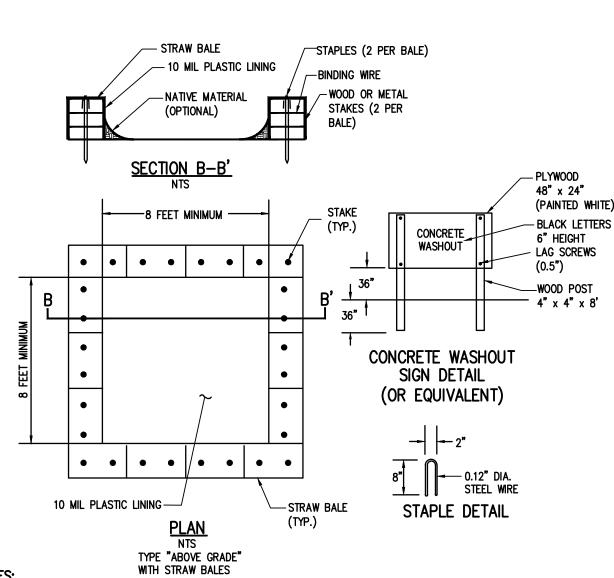


- ACTUAL LAYOUT DETERMINED IN THE FIELD. LOCATE THE FACILITY A MINIMUM OF 100 FEET FROM DRAINAGE SWALES, STORM DRAIN INLETS, WETLANDS, STREAMS AND OTHER SURFACE WATERS.
- THE MINIMUM SIZE SHALL BE 8 FEET BY 8 FEET AT THE BOTTOM AND 2 FEET DEEP. IF EXCAVATED, THE SIDE SLOPES SHALL BE 2 HORIZONTAL TO 1 VERTICAL.

3. THE CONCRETE WASHOUT SIGN SHALL BE INSTALLED WITHIN 30' OF THE TEMPORARY CONCRETE WASHOUT FACILITY.

- 3. WASHOUT STATION SHOULD BE CLEANED WHEN CONCRETE ACCUMULATES TO 75% OF THE STORAGE VOLUME. ANY EXCESS WASH WATER SHALL BE PUMPED INTO A CONTAINMENT VESSEL AND PROPERLY DISPOSED OF OFF SITE.
 - **CONCRETE WASHOUT DETAIL**

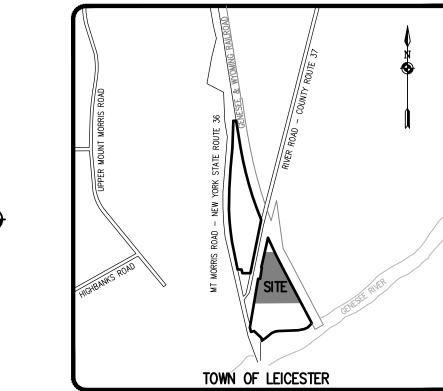

LOCATION MAP NOT TO SCALE

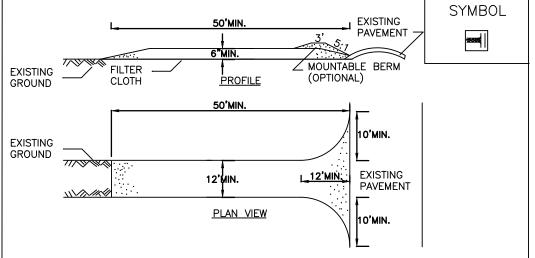

CONSTRUCTION SPECIFICATIONS

- . STONE SIZE USE 1—4 INCH STONE, OR RECLAIMED OR RECYCLED CONCRETE EQUIVALENT.
- 2. LENGTH NOT LESS THAN 50 FEET (EXCEPT ON A SINGLE RESIDENCE LOT WHERE A 30 FOOT MINIMUM LENGTH WOULD APPLY).
- 3. THICKNESS NOT LESS THAN SIX (6) INCHES.
- 4. WIDTH TWELVE (12) FOOT MINIMUM, BUT NOT LESS THAN THE FULL WIDTH AT POINTS WHERE INGRESS OR EGRESS OCCURS. TWENTY-FOUR (24) FOOT IF SINGLE
- 5. GEOTEXTILE WILL BE PLACED OVER THE ENTIRE AREA PRIOR TO PLACING OF STONE. 5. SURFACE WATER - ALL SURFACE WATER FLOWING OR DIVERTED TOWARD CON-
- STRUCTION ACCESS SHALL BE PIPED BENEATH THE ENTRANCE. IF PIPING IS IMPRACTICAL, A MOUNTABLE BERM WITH 5:1 SLOPES WILL BE PERMITTED.
- MAINTENANCE THE ENTRANCE SHALL BE MAINTAINED IN A CONDITION WHICH WILL PREVENT TRACKING OR FLOWING OF SEDIMENT ONTO PUBLIC RIGHTS-OF-WAY, ALL SEDIMENT SPILLED, DROPPED, WASHED OR TRACKED ONTO PUBLIC RIGHTS-OF-WAY MUST BE REMOVED IMMEDIATELY.
- 3. WHEN WASHING IS REQUIRED, IT SHALL BE DONE ON A AREA STABILIZED WITH STONE AND WHICH DRAINS INTO AN APPROVED SEDIMENT TRAPPING DEVICE. 9. PERIODIC INSPECTION AND NEEDED MAINTENANCE SHALL BE PROVIDED AFTER EACH

W/ MAX. 6" MESH

SPACING)

SECTION VIEW

ADAPTED FROM DETAILS PROVIDED BY: USDA - NRCS,
NEW YORK STATE DEPARTMENT OF TRANSPORTATION,
NEW YORK STATE DEPARTMENT OF ENVIRONMENTAL CONSERVATION,
NEW YORK STATE SOIL & WATER CONSERVATION COMMITTEE

10' MAX. C. TO C.

PERSPECTIVE VIEW

WOVEN WIRE FENCE (MIN. 14

SPACING) WITH FILTER CLOTH

6" MAXIMUM MESH OPENING.

"BULGES" DEVELOP IN THE SILT FENCE.

1/2 GAUGE W/ MAX. 6" MESH

36" MIN. FENCE POST

COMPACTED SOIL -

CONSTRUCTION SPECIFICATIONS

. WOVEN WIRE FENCE TO BE FASTENED SECURELY TO FENCE POSTS WITH WIRE TIES

2. FILTER CLOTH TO BE TO BE FASTENED SECURELY TO WOVEN WIRE FENCE WITH TIES

WHEN TWO SECTIONS OF FILTER CLOTH ADJOIN EACH OTHER THEY SHALL BE OVER-

LAPPED BY SIX INCHES AND FOLDED. FILTER CLOTH SHALL BE EITHER FILTER X,

4. PREFABRICATED UNITS SHALL BE GEOFAB, ENVIROFENCE, OR APPROVED EQUIVALENT.

5. MAINTENANCE SHALL BE PERFORMED AS NEEDED AND MATERIAL REMOVED WHEN

OR STAPLES. POSTS SHALL BE STEEL EITHER "T" OR "U" TYPE OR HARDWOOD.

SPACED EVERY 24" AT TOP AND MID SECTION. FENCE SHALL BE WOVEN WIRE,

EMBED FILTER CLOTH

MIRAFI 100X, STABILINKA T140N, OR APPROVED EQUIVALENT.

ADAPTED FROM DETAILS PROVIDED BY: USDA - NRCS,

NEW YORK STATE DEPARTMENT OF TRANSPORTATION,
NEW YORK STATE DEPARTMENT OF ENVIRONMENTAL CONSERVATION,

NEW YORK STATE SOIL & WATER CONSERVATION COMMITTEE

A MIN. OF 6" IN GROUND.

STABILIZED CONSTRUCTION ACCESS

36" MIN. LENGTH FENCE POSTS DRIVEN MIN. 16'

UNDISTURBED GROUND

16"MIN.



The following is an excerpt from the New York State Education Law Article

person, unless he is acting under the direction of a licensed professional

engineer or land surveyor to alter any

item in any way. If an item bearing th

seal of an engineer or land surveyor is altered, the altering engineer or land

surveyor shall affix to the item his seal

by his signature and the date of such

alteration, and a specific description of the alteration."

145 Section 7209 and applies to this "It is a violation of this law for any

PROJECT MANAGER L SWEDROCK PROJECT ENGINEER JL SWEDROCK DRAWN BY M SERENI SCALE DATE ISSUED


OCTOBER 2021 PROJECT NO.

DRAWING NO.

NOT APPROVED This plan has not received final approval of all reviewing agencies. This plan is subject to revisions


should not be used for construction

SILT FENCE until all approvals are obtained and

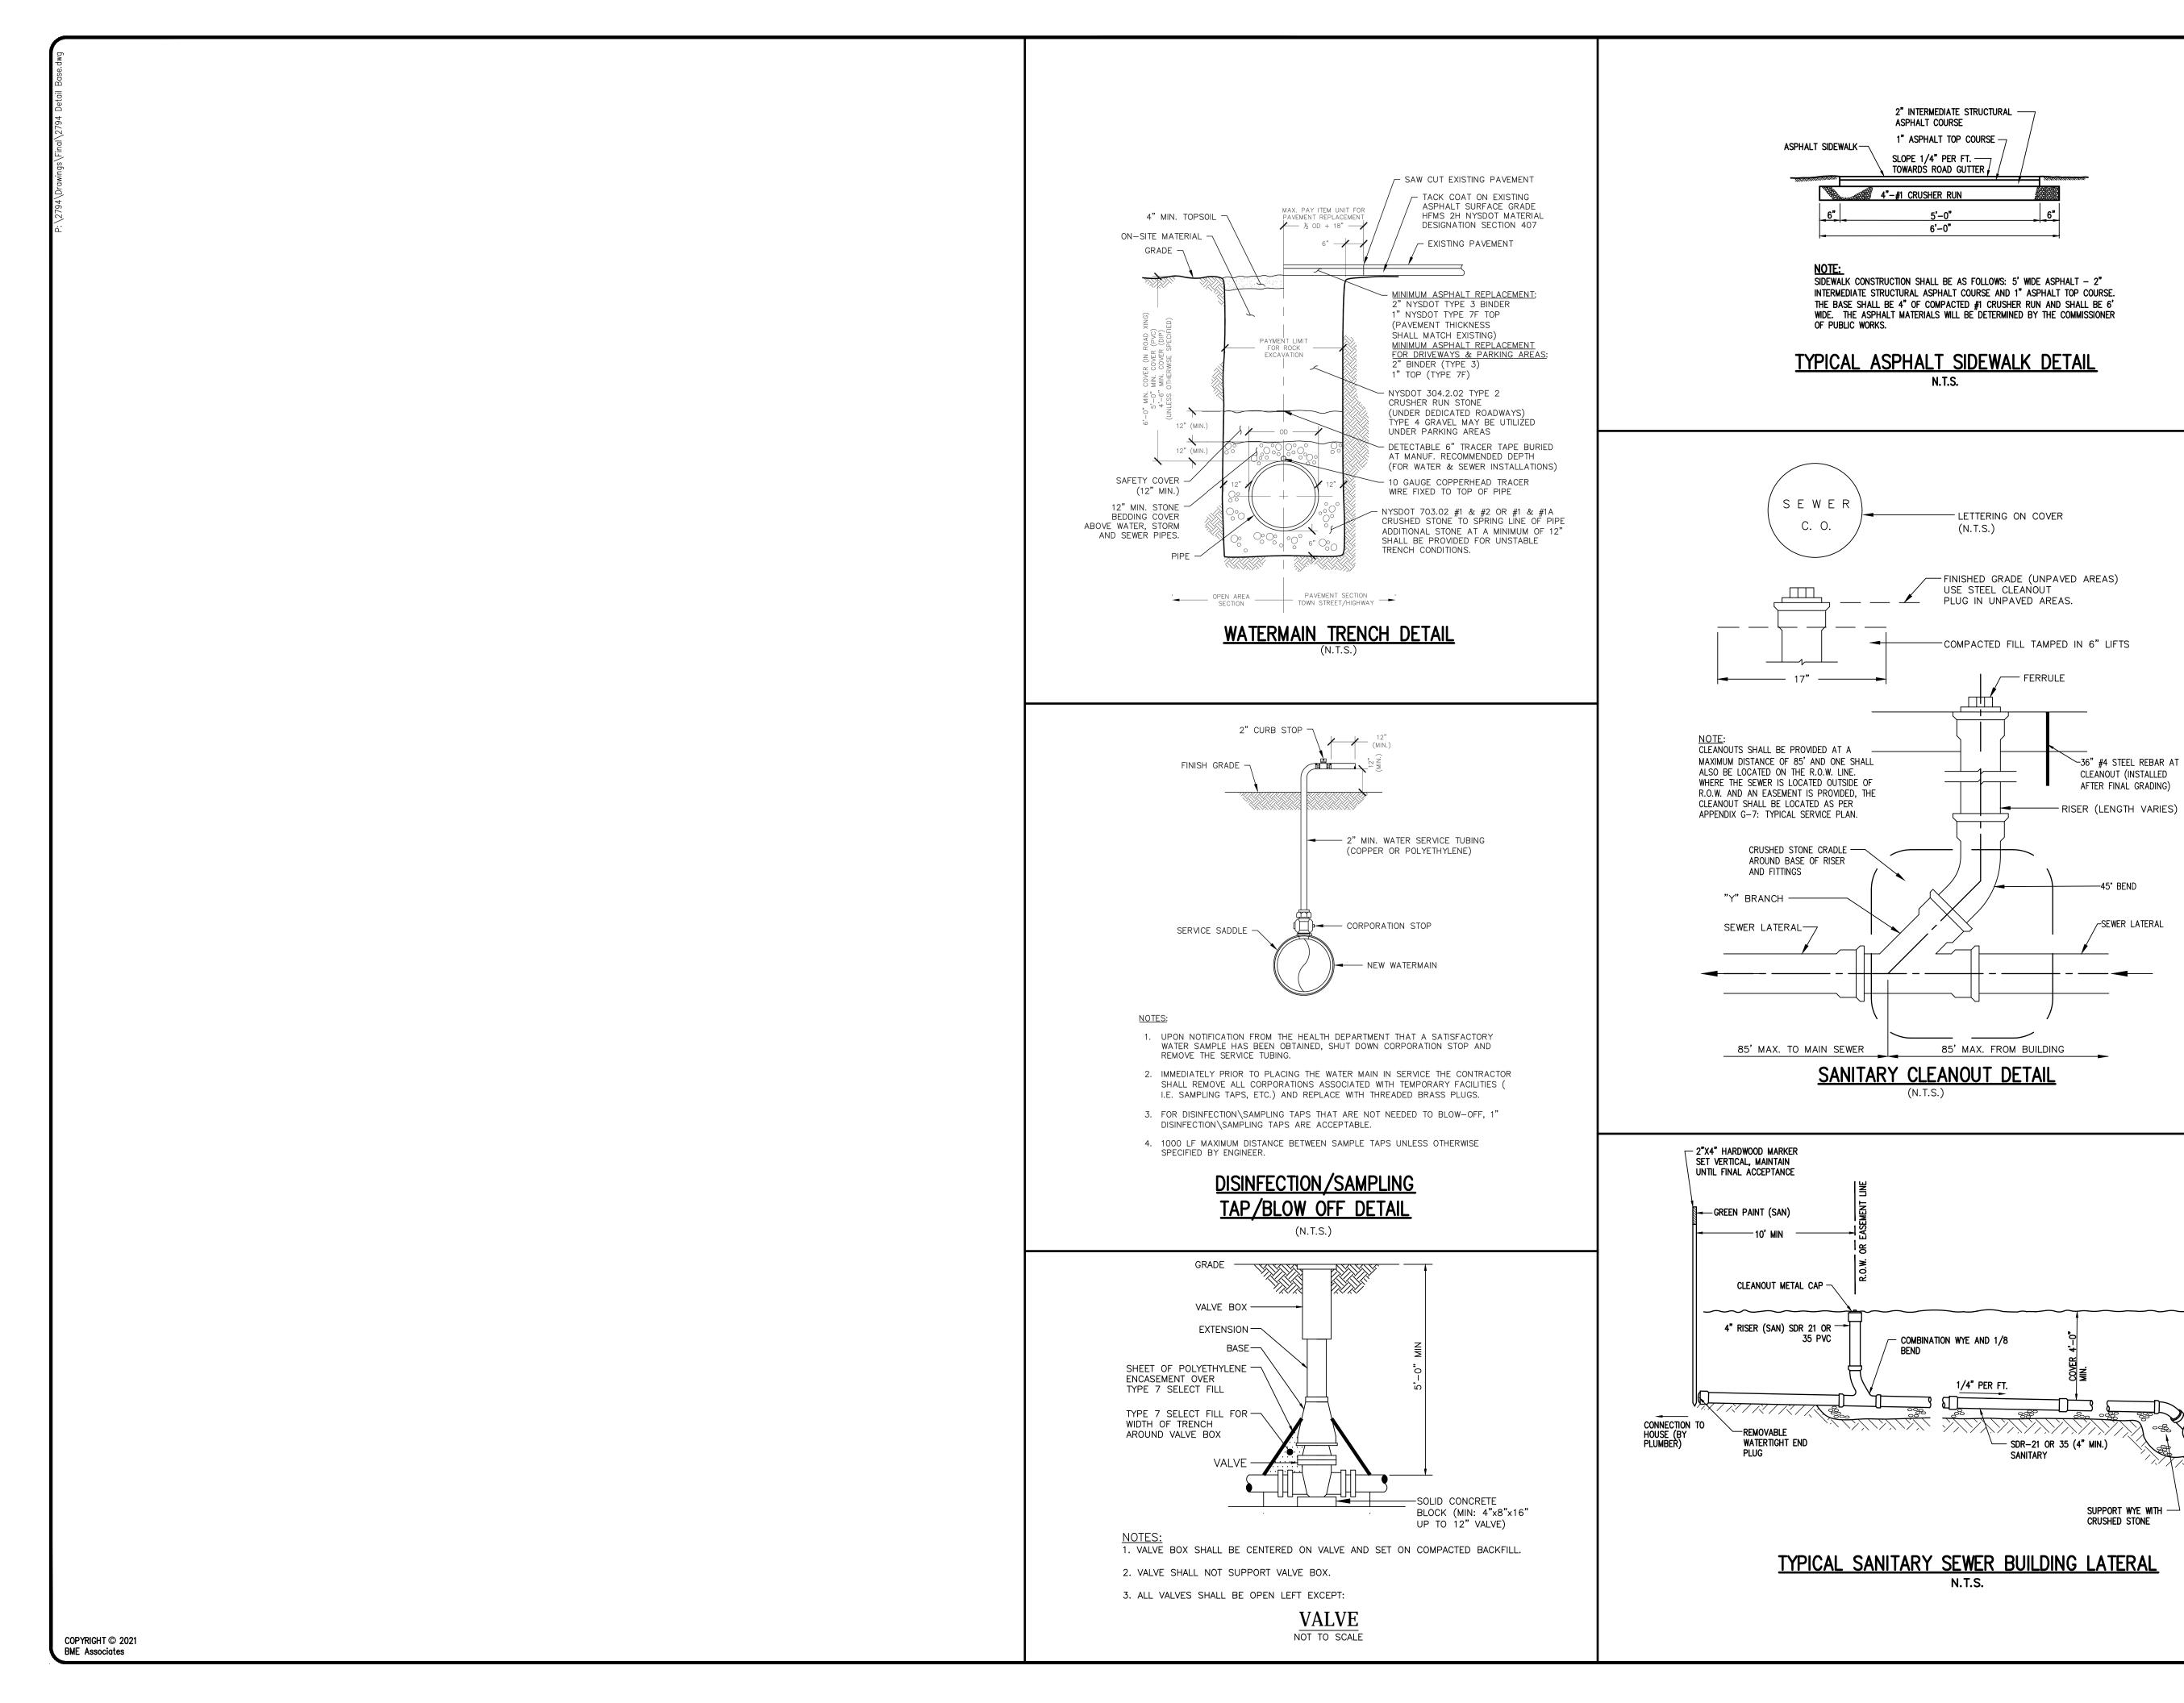

Drawing Alteration The following is an excerpt from the New York State Education Law Article 145 Section 7209 and applies to this

drawing: "It is a violation of this law for any person, unless he is acting under the direction of a licensed professional engineer or land surveyor to alter any item in any way. If an item bearing the seal of an engineer or land surveyor is altered, the altering engineer or land surveyor shall affix to the item his seal and the notation "altered by" followed by his signature and the date of such alteration, and a specific description of the alteration."

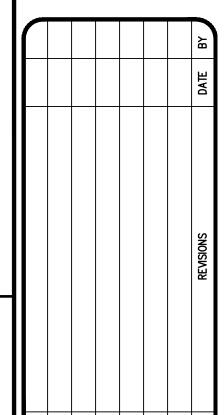

S



-45° BEND

PROJECT MANAGER JL SWEDROCK PROJECT ENGINEER JL SWEDROCK DRAWN BY M SERENI SCALE DATE ISSUED OCTOBER 2021

PROJECT NO.

DRAWING NO.

TOWN OF LEICESTER <u>APPLICATION FOR REVIEW AND APPROVAL OF SITE PLAN</u> <u>Application Fee: \$25.00 – Payable to Town of Leicester</u>

Name of Project/Development: Seneca Foods Con	rporation
Applicant Name: Seneca Foods Corporation	Owner, if different Name:
PO Box 278, 5705 Route 36 Address: Leicester, NY 14481	Address:
Phone #: (585) 664-4934	Phone #:
Town Invoices to be sent to:	
Name: Tammi Beaumont	Email: tbeaumont@senecafoods.com
5705 Route 36 Address: Leicester, NY 14481	Town/City: Leicester
Phone #: (585) 658-2211	Zip: _14481
I, the undersigned applicant/owner/other, her Board for the attached site plan(s).	reby request approval by the Town of Leicester Planning
Name: Ryan Schuyler R	elationship/Company/Contractor: Plant Manager
Address: 5705 Route 36, Leicester, NY 14481	
Contact Email: rschuyler@senecafoods.com	Phone #: (585) 658-2211, ext. 60237
Plan prepared and signed by the following licens	sed engineer and/or land surveyor:
Name: BME Associates	Phone#: (585) 377-7360
Address: 10 Liftbridge Lane East Fairport, NY 14450	Email: lswedrock@bmepc.com
Proposed use of site: Proposed +/-4,460 s.f. residentia	al accessory building, including a future +/-4,460 s.f. residential
accessory building with connection to public water and sev	wer.
APPLYING FOR TAX EXEMPTION?(other	than a RPTL485-b, business exemption) YES <u>X</u> NO
WILL YOU BE APPLYING FOR A PILOT A	AGREEMENT? YES X NO
Description of location for proposed site plan (di	stance and direction to nearest road intersection):
Proposed residential accessory buildings located east of N	YS Route 37.

Site Plan Application, page 2

Tax Map # 97.00-1-33.1 Current total site area (sq. ft./acres) 20.3 AcTotal site area when developed: 20.3 Actor (sq. ft./acres) 20.3 A
Current use of land/site: Existing Seneca Foods Corporation plant.
Zoning district: I (IND)
Current condition of the site (buildings, brush, etc)?: Existing buildings/lawn
Character of the surrounding lands (agricultural, wetlands, commercial, residential, etc.): Agricultural
Is the property in a flood hazard district area? No
Is there an easement, right-of-way, or some other restriction on the property? (Where?)YES XNO
Neighbors/Businesses within 500 ft. (also addresses, if available): N/A
ARE THERE ANY STATE AND FEDERAL PERMITS REQUIRED?YES _XNO LIST TYPE AND APPROPRIATE DEPARTMENT:

ADDITIONAL FORMS REQUIRED:

• SEQRA FORM: Check with Code Enforcement Officer (phone 585-519-6289) to see which EAF form is needed.

Please note: If SSEQRA long form is indicated, see DEC website.

• AG DATA STATEMENT:

If the proposed activity will be located on property containing a farm operation or on property with boundaries withing 500' located in an agricultural district, then an **Ag Data Statement** must be completed.

Check with the Town Assessor (585-382-3231) or Real Property (585-243-7192) for property owners to be listed on the form.

Site Plan Application, page 3

1. Proposed building location: +/-220' east of County Road 37.	
2. Building uses, primary and secondary uses, ground floor area height, and number One-story accessory residential structures proposed.	r of stories of each building:
3. Building(s) architecture/colors/textures/design compatibility with the character of Provided building elevations and floor plans.	f the Town of Leicester:
4. Parking (number of spaces and location relating to highway): None proposed.	
5. Lighting/Landscape (plans required): N/A, typical residential structure	
6. Traffic/Road(s) location County Road 37 7. Is public water available? X YES NO Is public sewer available	e? X_YESNO
This application was reviewed by the Code Enforcement Office.	
Signature	Date

NAME	FLO	BAS	E	WAI	_L	CEIL	ING		
	ГЛТ	CERAMIC TILE	SEALED CONCR	4" VINYL @ GYP BD WALLS	4" TILE COVE BASE	PAINT ON GYP BD	CERAMIC TILE TO 4'	PAINT ON GYP BD	ILINON ON
100 ENTRY	•			•		•		•	
IOI HALLWAY	•			•		•		•	
102 BUNK ROOM	•			•		•		•	
103 BUNK ROOM	•			•		•		•	
104 BUNK ROOM	•			•		•		•	
105 BUNK ROOM	•			•		•		•	
106 BUNK ROOM	•			•		•		•	
107 BUNK ROOM	•			•		•		•	
108 BUNK ROOM	•			•		•		•	
109 UTILITY			•	•		•	•	•	
IIO MEN		•			•	•	•	•	
III STORAGE		•			•	•		•	
112 M SHOWER		•			•	•	•	•	
113 W SHOWER		•			•	•	•	•	
114 WOMEN		•			•	•	•	•	
115 STORAGE		•			•	•		•	
IIG LAUNDRY		•			•	•		•	

BCNYS 804: All floor finishes to be min class 2 critical radiant flux BCNYS 1210.1: Floors in toilet/ bathing rooms to have smooth, hard, nonabsorbent surface extending 4" up walls BCNYS 1210.2: Walls within 2' of urinals and water closets to have smooth, hard, nonabsorbent surface to a height of 4ft above floor minimum

IUMBER	ROOM	TYPE	MATL	WIDTH	HEIGHT	THICK	FINISH	RATING	HDW	FTYPE	FMATL	FFIN	FRDEPTH	REMARKS
100	ENTRY	В	НМ	3'-0"	7'-0"	I -3/4"	PAINT	-	2	FI	НМ	PAINT	8-7/8"	Exterior
101	HALLWAY	Α	НМ	3'-0"	7'-0"	1-3/4"	PAINT	-	2	FI	НМ	PAINT	8-7/8"	Exterior
102	BUNK ROOM	Α	SC/OAK VENEER	3'-0"	7'-0"	1-3/4"	CLEAR	-	3	FI	НМ	PAINT	5-3/4"	-
103	BUNK ROOM	Α	SC/OAK VENEER	3'-0"	7'-0"	1-3/4"	CLEAR	-	3	FI	НМ	PAINT	5-3/4"	-
104	BUNK ROOM	А	SC/OAK VENEER	3'-0"	7'-0"	1-3/4"	CLEAR	-	3	FI	НМ	PAINT	5-3/4"	-
105	BUNK ROOM	Α	SC/OAK VENEER	3'-0"	7'-0"	1-3/4"	CLEAR	-	3	FI	НМ	PAINT	5-3/4"	_
106	BUNK ROOM	Α	SC/OAK VENEER	3'-0"	7'-0"	1-3/4"	CLEAR	-	3	FI	НМ	PAINT	5-3/4"	-
107	BUNK ROOM	Α	SC/OAK VENEER	3'-0"	7'-0"	1-3/4"	CLEAR	-	3	FI	НМ	PAINT	5-3/4"	-
108	BUNK ROOM	Α	SC/OAK VENEER	3'-0"	7'-0"	1-3/4"	CLEAR	-	3	FI	НМ	PAINT	5-3/4"	-
109	UTILITY	Α	SC/OAK VENEER	3'-0"	7'-0"	1-3/4"	CLEAR	-	3	FI	НМ	PAINT	5-3/4"	-
110	MEN	Α	SC/OAK VENEER	3'-0"	7'-0"	1-3/4"	CLEAR	-	5	FI	НМ	PAINT	5-3/4"	-
111	STORAGE	Α	SC/OAK VENEER	3'-0"	7'-0"	1-3/4"	CLEAR	-	3	FI	НМ	PAINT	5-3/4"	-
112	M SHOWER		not used											
113	W SHOWER		not used											
114	WOMEN	Α	SC/OAK VENEER	3'-0"	7'-0"	1-3/4"	CLEAR	-	5	FI	НМ	PAINT	5-3/4"	-
115	STORAGE	А	SC/OAK VENEER	3'-0"	7'-0"	1-3/4"	CLEAR	-	3	FI	НМ	PAINT	5-3/4"	-
116	LAUNDRY		not used											

PADDLE HANDLE STRIKE
ENTRANCE LEVER
PASSAGE LEVER
PRIVACY LEVER
PUSH/PULL SELF CLOSING
BYPASSING/ SLIDING
ELECTRIC LIFT
MANUAL LIFT

· · · · · CLASSROOM LEVER


ALL EXTERIOR DOORS TO INCLUDE: THRESHOLD WEATHERSTRIPPING

INSULATED


HARDWARE GROUPS


SELF-CLOSING DEVICE


ALL RATED DOORS AND VESTIBULE DOORS TO INCLUDE SELF CLOSING DEVICE

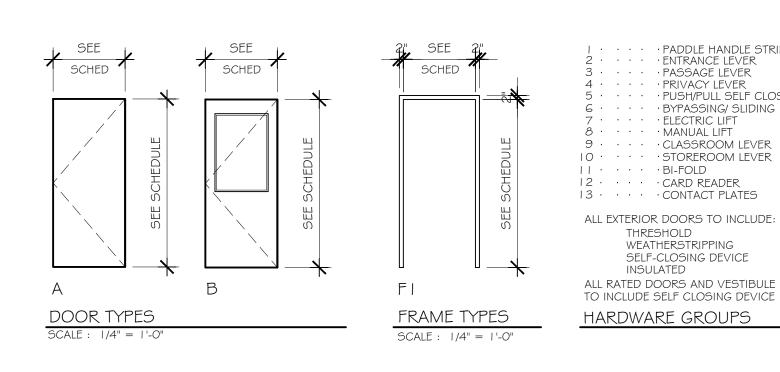



A	(A) WINDOW SCHEDULE										
NUMBER	TYPE	SIZE (WxH)	DEPTH	FRAME	FINISH	GLASS	NOTE	QTY			
А	WI	6'-0" x 3'-6"	4-1/2"	VINYL	PRE-FIN	INSULATED	GLIDER	16			
В	W2	4'-0" x 1'-6"	4-1/2"	VINYL	PRE-FIN	INSULATED	AWNING	6			

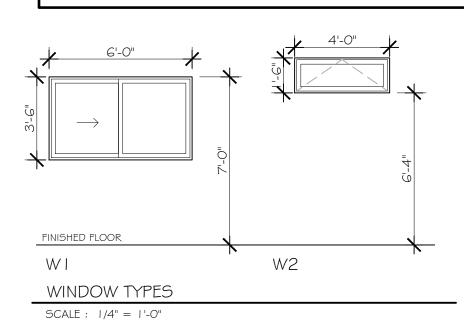

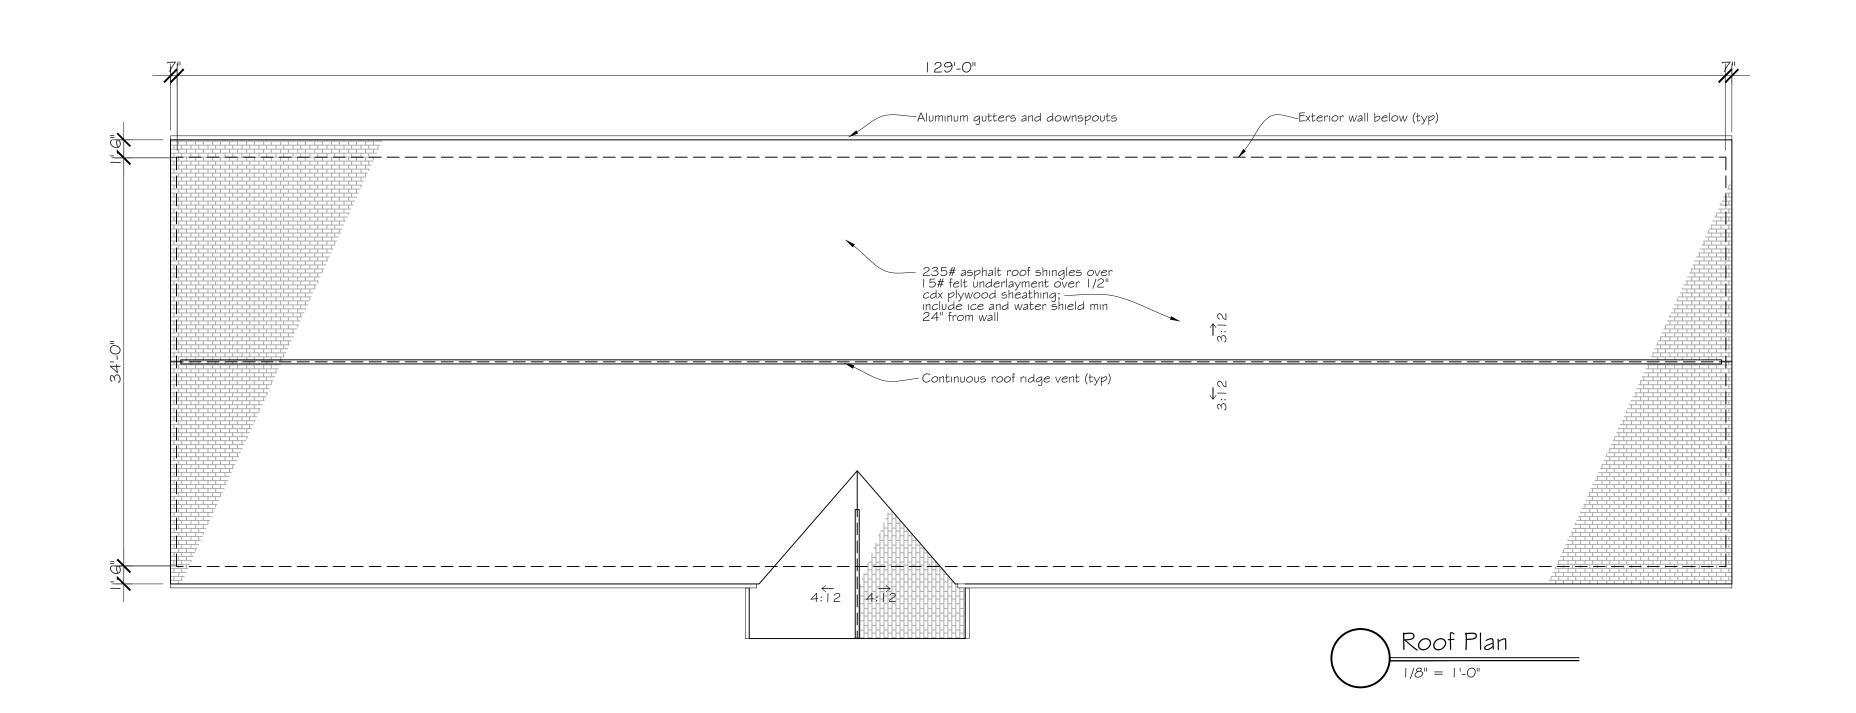

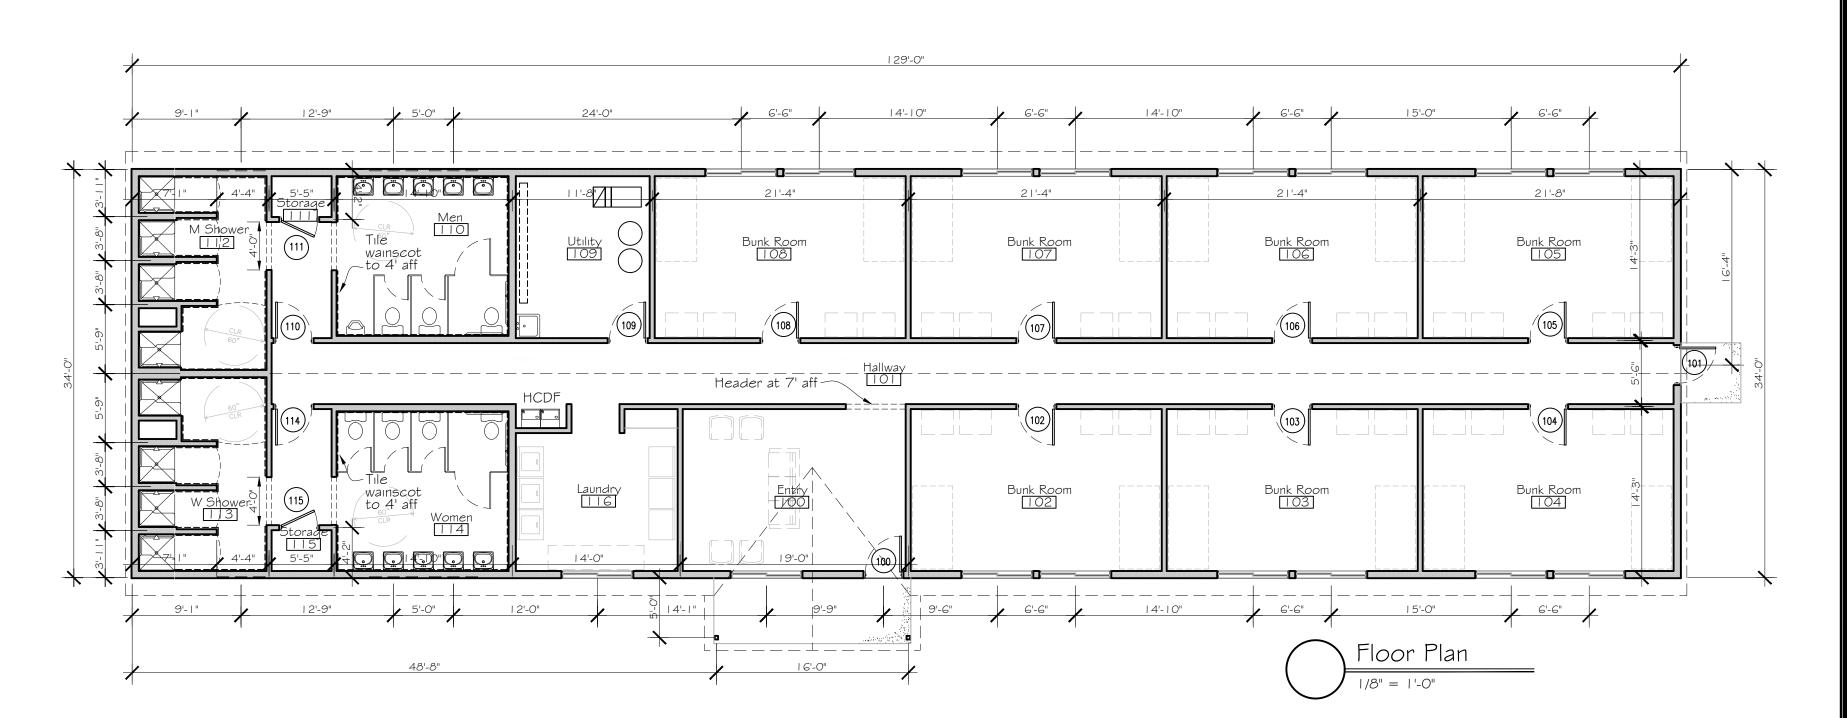

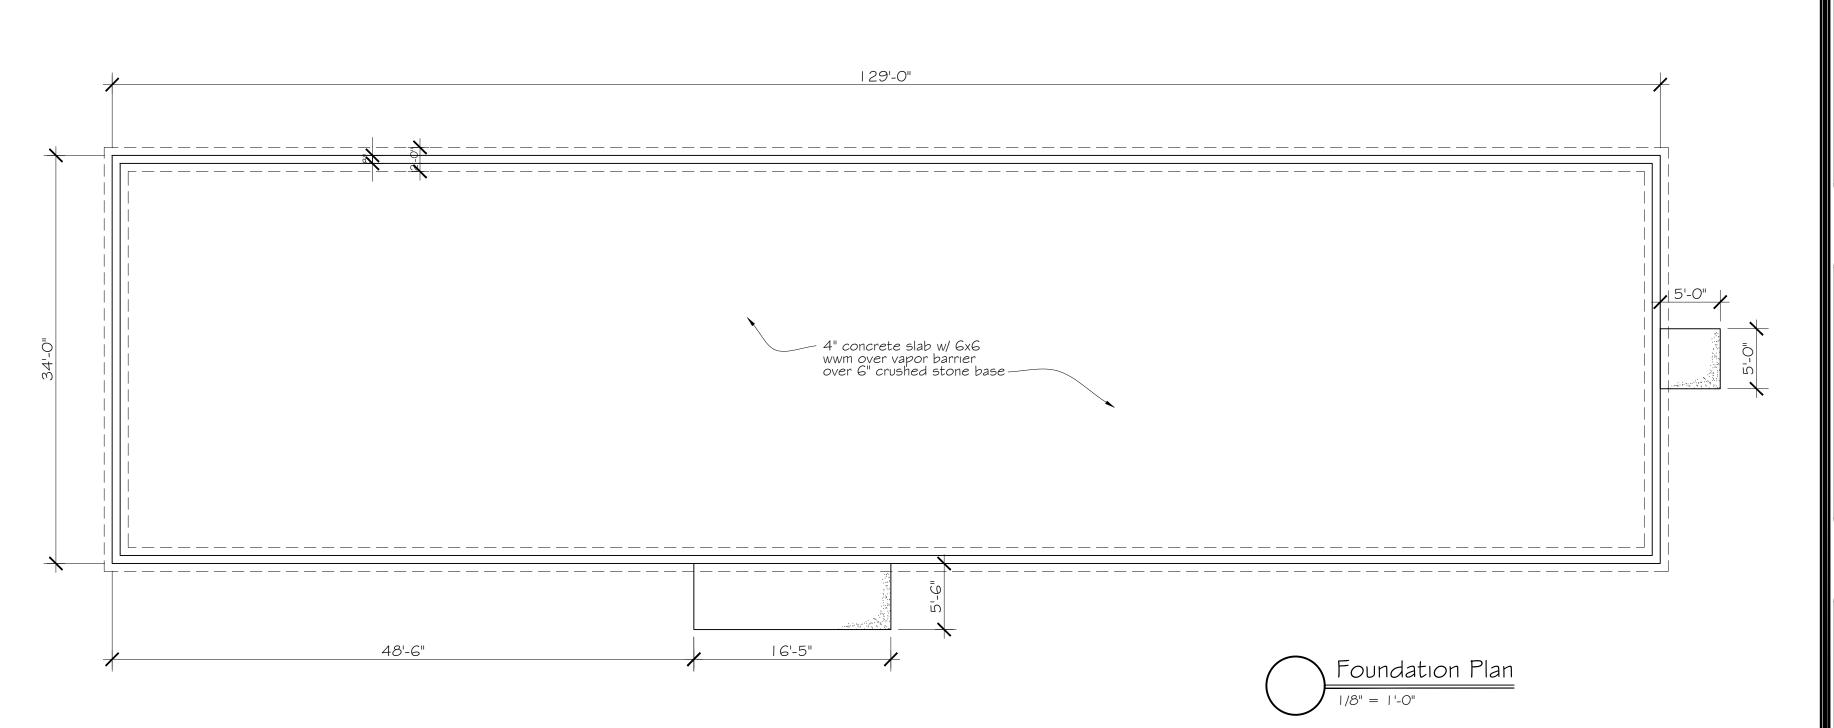

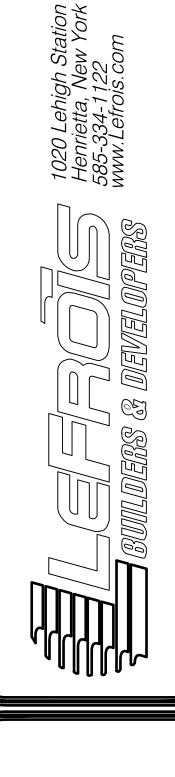

DRAWING ALTERATION

The following is an excerpt from the NYCRR Title VIII Ch II Part 69.5b and applies to thi unless acting under the direct supervision of licensed architect or a licensed professiona engineer, to alter an item on this document arcnitect or engineer is altered, the altering architect or engineer shall affix their seal and the notation "Altered by" followed by their signature and date of such alteration and a specific description of the alteration."

REVISIONS 10-18-2021 SSUED FOR FINAL BIDDING

PROJECT

Seneca Foods Farmworker Housing


LOCATION


5705 NY-36 Town of Leicester Livingston County New York


DRAWING TITLE Proposed Floor Plan

As noted



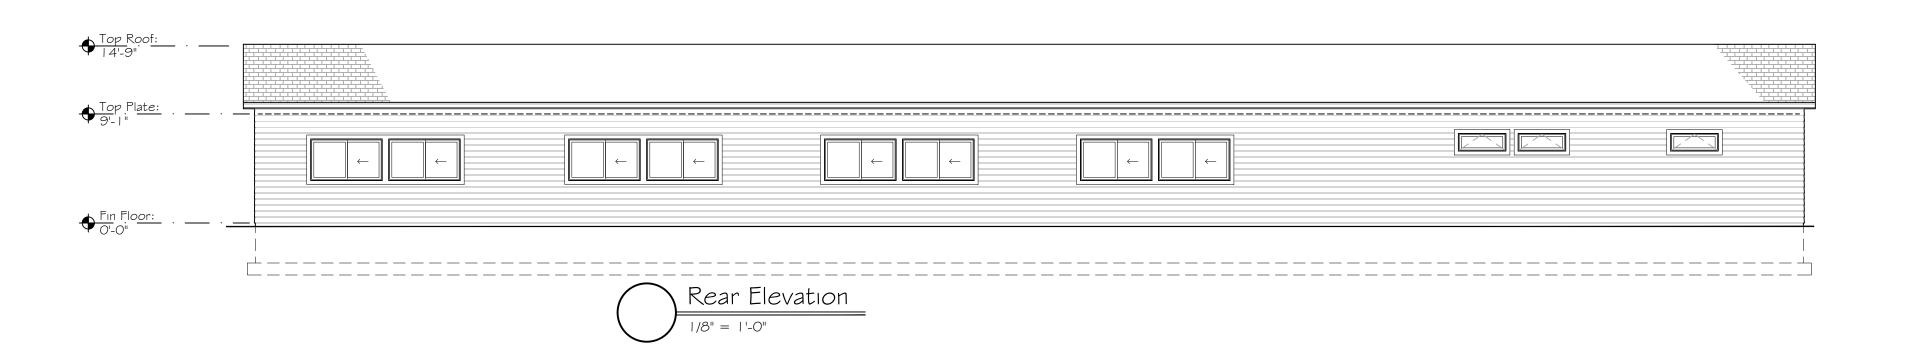

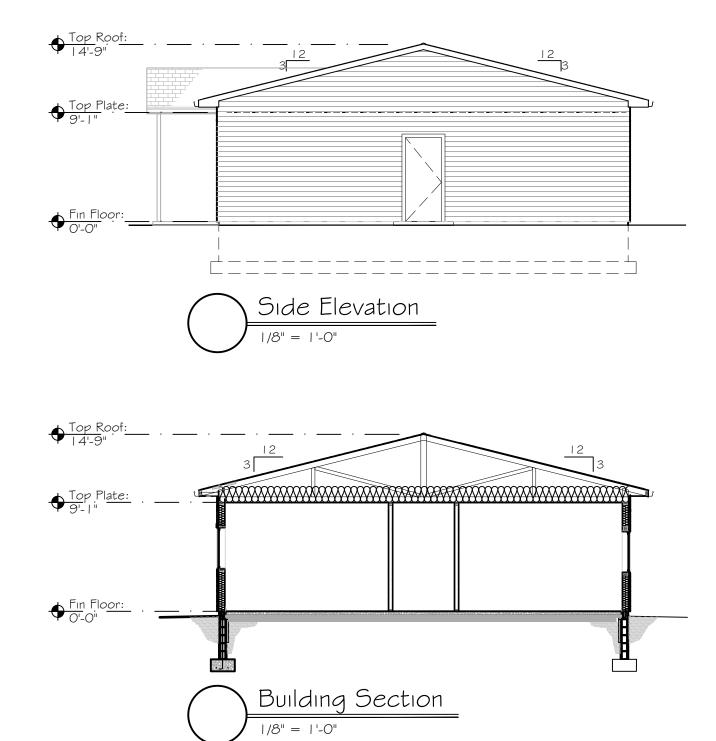

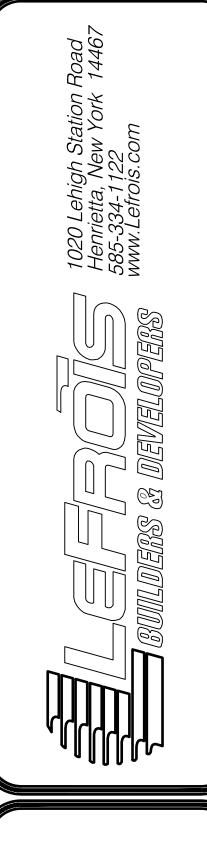

DRAWING ALTERATION

The following is an excerpt from the NYCRR Title VIII Ch II Part 69.5b and applies to this drawing:
"It is a violation of this law for any person, unless acting under the direct supervision of licensed architect or a licensed professional engineer, to alter an item on this document is any way. If an item bearing the seal of an architect or engineer is altered, the altering architect or engineer shall affix their seal and the notation "Altered by" followed by their signature and date of such alteration and a specific description of the alteration."

	RESS PLOT	10-18-2021	
ISSUE	D FOR FINAL	BIDDING	
ISSUE	D FOR PERM	1IT	
ISSUE	D FOR CONS	ST.	
NO.	DATE	DESCRIPTION	

PROJECT

Seneca Foods
Farmworker Housing

LOCATION

5705 NY-36 Town of Leicester Livingston County New York

DRAWING TITLE

Exterior Elevations

Wall Section

SHEET NO.

-2 DRAW

CHECKED BY: EDATE: Feb

TOWN OF LEICESTER AGRICULTURAL DATA STATEMENT

Applicant:	Owner (if different)
Name: Seneca Foods Corporation	N/A
Address: PO Box 278	
5705 Route 36, Leicester, NY 14481	
List the farmland owners of the lands that are in an agriculture boundary of the property of the proposed project. Thornapple Dairy Name: Farming Benefit Trust (T.A. #97.00-01-48)	Name:
Address: 5672 Upper Mt. Morris Road Leicester, NY 14481	Address:
Name: Sara Scondras Address: River Road (T.A. #97.00-01-31.1) 3899 Huston Road Geneseo, NY 14454	Name:Address:
PLEASE INCLUDE A MAP SHOWING THE SITE (OF THE PROJECT RELATIVE TO THE FARM
Description of the proposed project and its location: Location of site: 5705 Route 36 Tax Map # 97.00-01-33.1	
Total site area in square feet or acres:	
Ownership intentions/ proposed use of site: Seneca Fo	ods Corporation
Anticipated construction time: 2022	
Brief description of farm operation (s) that might be a Existing industrial zoning district agricultural plant operation	ons to be affected during construction.
<u> </u>	es as Agent to Seneca Foods the Applicant
Signature of applicant/owner	•

LANDMAX		Ŋ	<i>l</i> lain Rec	ord				10	0/27/2021	
「ax ID	Owr		Autorition -			Print k	-			
97.000-0001-031.00100	SCC	NDRA	S SARA			971-				
Street Address		Owner	B***			Munic			SWIS COD	
RIVER RD		JULIA					OF LEICES		243089	
Mailing Address 1899 HUSTON RD	Sub	divisio	n / Cross Sti	reet		•	rty Descripti FARMLAND	on		
GENESEO, NY 14454							ode 105			
Year Built 0	Heat		# of Bedroo		0.0	Sq. Footage	<u> </u>	# of Sto	ries 0	
House Type	Fuel		# of Baths	71113		1st Floor SC		# Res. U		
Basement	Water NO	NE				2nd Floor S		# of Bui		
Exterior	Sewer PUI	3LIC	# of Firepla	ces	0	Base SQFT	(ິ່#of Gar	ages	
	Central Air	•						Story He	eight 0	
Assessment	\$74,	900	School		M.	TMORRIS	North	1002788		
Land Value	\$74,	900	School Tax	ĸ	\$1	,576.65	East	1338542		
Equalization Value 1009	% \$74,	900					Latitude	42.75006	355	
Account #		0	County Ta	X	\$1	,102.53	Longitude	-77.8750	07	
Improvements Improvement Type	Dimensions	SQ. F	eet Year		lmpro	vement Typ	e Dimens	ions SQ.F	eet Yea	
# 1	0 X 0	0		#3			0 X 0	0		
# 2	0 X 0	0		#4			0 X 0	0		
Land Characteri	stics	Tota Acre	80.00		Land SQ FT	3,484,800	Lo ¹ Siz	- ^ ^ ^		
Primary	Secondary		Lease	d		Undev	eloped	Wood	ded	
Wetlands	Water Front		Residu	ıal	Tillabe			Pasture 63.00		
Waste 17.00	Muck		Orcha	rds		Vineya	rds	Rear		
Sales History	44//									
Grantor	Sale Price)	Sale Date		Deed Boo		Deed Valid	Deed Type	ARMS Lengtl	
					·········					
			11							
								-		


Notes

LANDMAX		N	lain Rec	ord				10/2	7/2021	
Tax ID 097.000-0001-048.00000 Street Address 5672 UPPER MT MORRIS	THOP	Owner THORNAPPLE DAIRY FARMING Co Owner					(ey 48 ipality N OF LEICES ⁻	SWIS CODE TER 243089		
Mailing Address 2414 JONES BRIDGE RD LEICESTER, NY 14481	Subd	ivisior	ı / Cross Str	eet		Prope FIELD	rty Description CROPS ode 120		2-10000	
Year Built 1900 House Type OLD STYLE Basement FULL Exterior WOOD	Heat HOT Fuel GAS Water PUB Sewer PRI\ Central Air	LIC	# of Bedroo # of Baths # of Firepla		1.0	Sq. Footage 1st Floor S0 2nd Floor S Base SQFT	QFT 1,236 QFT 780	# of Storie # Res. Unit # of Buildi # of Garag Story Heig	ts 0 ngs 2 es 0	
Assessment Land Value Equalization Value 100 Account #	1,022,5 \$938,9 % 1,022,5	00	School Tax County Tax	-	\$2	TMORRIS :1,523.63 5,051.20	North East Latitude Longitude	1001557 1333886 42.7467939 -77.892379		
Improvements Improvement Type	Dimensions	SQ. Fe	eet Year		Impro	vement Typ	oe Dimensio	ons SQ. Fee	et Year	
#1 PORCH,COVERD #2 SHED,MACHINE	120 X 0 864 X 0	120 864				,MACHINE ,2.0 GEN	168 X 0 3960 X 0	168 3960	1940 1940	
Land Characteri	stics	Total Acres	3/5 NN		Land SQ FT	* *** ***	Lot Size	0 X 0		
Primary 1.00 Wetlands Waste 59.50	Secondary Water Front Muck		Leased Residu Orchar	al		Undeve Tillabe Vineya	11.20	Wooded Pasture Rear	84.10	
Sales History						**************************************				
Grantor	Sale Price		Sale Date		Deed	k Page	Deed Valid	Deed Type	ARMS Length	
THORNAPPLE DAIRY CB EQUIPMENT &	1		8/25/2015 9/30/2010		1275 1260	2778 1513			N	

Notes

LANDMAX		V	/lain Rec	ord				10/2	26/2021
Tax ID	Owr					Print k	-		
097.000-0001-033.00100		SENECA FOODS INC			971-33.1				
Street Address 5799 MT MORRIS RD	Co (Owner				Munic	ipality NOF LEICES		/IS CODE 243089
Mailing Address	Sub	divicion	ı / Cross Str	oot			rty Description		243008
Maining Addiess	Jubi	11112101	17 01055 311	GGL		-	JFACTURE	2(1	
LEICESTER, NY 14481							ode 710		
Year Built 1990	Heat		# of Bedroo	ms 0.	0 8	Sq. Footage	195,885	# of Storie	s 1
House Type	Fuel		# of Baths	0.0	0 1	st Floor SC	QFT 0	# Res. Uni	ts 0
Basement	Water PUE	BLIC			2	nd Floor S	QFT 0	# of Buildi	ings 1
Exterior	Sewer NO	VΕ	# of Firepla	ces	0 E	Base SQFT	0	# of Garaç	jes O
	Central Air	ı						Story Heig	jht 14
Assessment	2,492,0	000	School		MT	MORRIS	North	1000312	
Land Value	\$252,4	400	School Tax	·	\$52	2,456.60	East	1336580	
Equalization Value 100	% 2,492,0	000					Latitude	42.743317	
Account #		0	County Tax		\$36	6,682.24	Longitude	-77.882388	3
Improvements				•					
Improvement Type	Dimensions	SQ. F	eet Year	lmp	orov	ement Typ	e Dimensi	ons SQ. Fe	et Year
#1	0 X 0	0		# 3			0 X 0	0	
# 2	0 X 0	0		#4			0 X 0	0	
Land Characteri	stics	Total Acres	3G 10	Lar SQ		1,572,516	Lot Size	0 X 0	
Primary 15.00	Secondary		Leased			Undeve	eloped	Woode	d
Wetlands	Water Front		Residu	al 21.10		Tillabe		Pasture	.
Waste	Muck		Orchar			Vineya	rds	Rear	
Sales History				 , ,					
				De	eed	Deed	Deed	Deed	ARMS
Grantor	Sale Price	· I	Sale Date		ook		Valid	Туре	Length
						<u> </u>			
	1	1 .	' /	ı		1	1		

Notes			
		·	
	•		

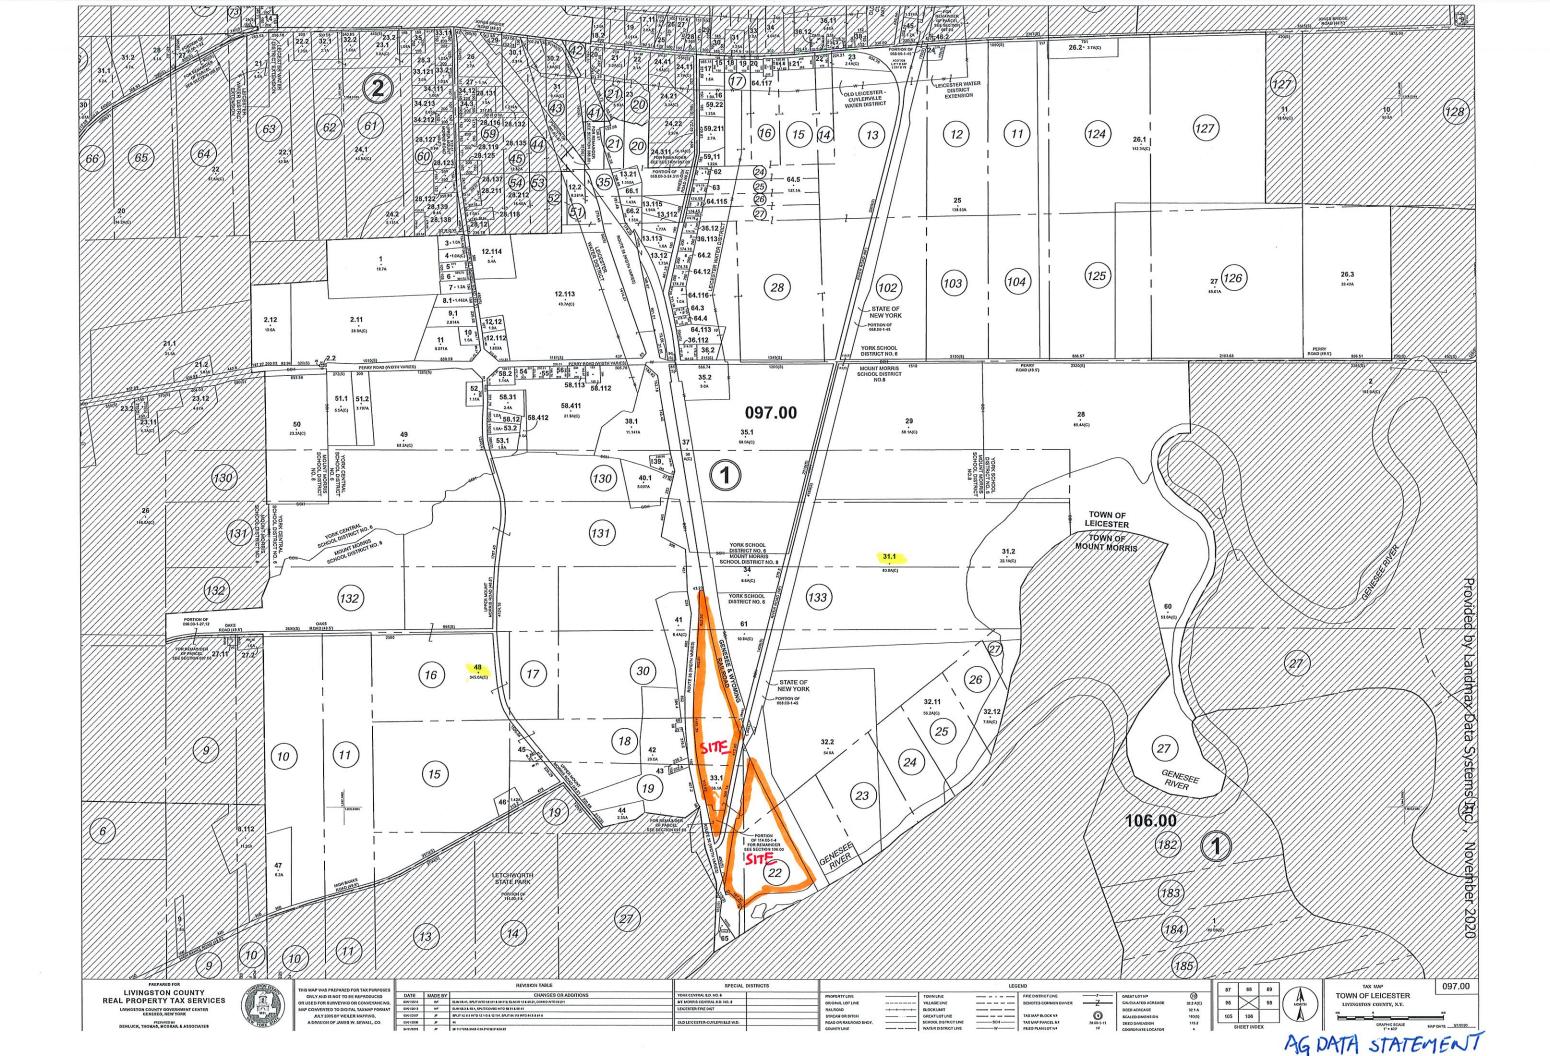

Short Environmental Assessment Form Part 1 - Project Information

Instructions for Completing


Part 1 – Project Information. The applicant or project sponsor is responsible for the completion of Part 1. Responses become part of the application for approval or funding, are subject to public review, and may be subject to further verification. Complete Part 1 based on information currently available. If additional research or investigation would be needed to fully respond to any item, please answer as thoroughly as possible based on current information.

Complete all items in Part 1. You may also provide any additional information which you believe will be needed by or useful to the lead agency; attach additional pages as necessary to supplement any item.

Part 1 – Project and Sponsor Information			
Name of Action or Project:			
Project Location (describe, and attach a location map):			
Brief Description of Proposed Action:			
Name of Applicant or Sponsor:		Telephone:	
		E-Mail:	
Address:			
City/PO:		State:	Zip Code:
1. Does the proposed action only involve the legislative ac administrative rule, or regulation?	option of a plan, loca	l law, ordinance,	NO YES
If Yes, attach a narrative description of the intent of the propagate may be affected in the municipality and proceed to Part 2. I			nat 🔲 🗀
2. Does the proposed action require a permit, approval or funding from any other government Agency? If Yes, list agency(s) name and permit or approval:			
a. Total acreage of the site of the proposed action?b. Total acreage to be physically disturbed?c. Total acreage (project site and any contiguous proper or controlled by the applicant or project sponsor?	ties) owned	acres acres acres	
4. Check all land uses that occur on, are adjoining or near t	he proposed action:		
5. Urban Rural (non-agriculture) Industry	rial Commercia	al Residential (subur	rban)
□ Forest Agriculture Aquat□ Parkland	ic Other(Spec	cify):	

5.	Is the proposed action,	NO	YES	N/A
	a. A permitted use under the zoning regulations?			
	b. Consistent with the adopted comprehensive plan?			
6	Is the proposed action consistent with the predominant character of the existing built or natural landscape?		NO	YES
6.	is the proposed action consistent with the predominant character of the existing built of natural fandscape?			
7.	Is the site of the proposed action located in, or does it adjoin, a state listed Critical Environmental Area?		NO	YES
If Y	es, identify:			
			NO	VEC
8.	a. Will the proposed action result in a substantial increase in traffic above present levels?		NO	YES
	b. Are public transportation services available at or near the site of the proposed action?			
	c. Are any pedestrian accommodations or bicycle routes available on or near the site of the proposed action?			
9.	Does the proposed action meet or exceed the state energy code requirements?		NO	YES
If the	ne proposed action will exceed requirements, describe design features and technologies:			
10.	Will the proposed action connect to an existing public/private water supply?		NO	YES
	If No, describe method for providing potable water:			
11.	Will the proposed action connect to existing wastewater utilities?		NO	YES
	If No, describe method for providing wastewater treatment:			
	a. Does the project site contain, or is it substantially contiguous to, a building, archaeological site, or district	t	NO	YES
Coı	ch is listed on the National or State Register of Historic Places, or that has been determined by the mmissioner of the NYS Office of Parks, Recreation and Historic Preservation to be eligible for listing on the te Register of Historic Places?			
arcl	b. Is the project site, or any portion of it, located in or adjacent to an area designated as sensitive for naeological sites on the NY State Historic Preservation Office (SHPO) archaeological site inventory?			
13.	a. Does any portion of the site of the proposed action, or lands adjoining the proposed action, contain wetlands or other waterbodies regulated by a federal, state or local agency?		NO	YES
	b. Would the proposed action physically alter, or encroach into, any existing wetland or waterbody?		H	
If Y	es, identify the wetland or waterbody and extent of alterations in square feet or acres:			

14. Identify the typical habitat types that occur on, or are likely to be found on the project site. Check all that apply:		
☐Shoreline ☐ Forest Agricultural/grasslands Early mid-successional		
Wetland Urban Suburban		
15. Does the site of the proposed action contain any species of animal, or associated habitats, listed by the State or	NO	YES
Federal government as threatened or endangered?		
16. Is the project site located in the 100-year flood plan?	NO	YES
17. Will the proposed action create storm water discharge, either from point or non-point sources?	NO	YES
If Yes,		
a. Will storm water discharges flow to adjacent properties?		
b. Will storm water discharges be directed to established conveyance systems (runoff and storm drains)? If Yes, briefly describe:		
l ————————————————————————————————————		
18. Does the proposed action include construction or other activities that would result in the impoundment of water	NO	YES
or other liquids (e.g., retention pond, waste lagoon, dam)? If Yes, explain the purpose and size of the impoundment:		
The second in the purpose and size of the impoundment.		
49. Has the site of the proposed action or an adjoining property been the location of an active or closed solid waste management facility?	NO	YES
If Yes, describe:		
20. Has the site of the proposed action or an adjoining property been the subject of remediation (ongoing or	NO	YES
completed) for hazardous waste? If Yes, describe:		
I CERTIFY THAT THE INFORMATION PROVIDED ABOVE IS TRUE AND ACCURATE TO THE BE	ST OF	
MY KNOWLEDGE	OI OI	
Applicant/sponsor/name:		
Signature: <u>J. Lincoln Swedrock</u>		

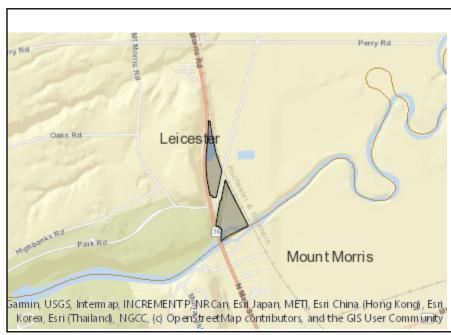

Disclaimer: The EAF Mapper is a screening tool intended to assist project sponsors and reviewing agencies in preparing an environmental assessment form (EAF). Not all questions asked in the EAF are answered by the EAF Mapper. Additional information on any EAF question can be obtained by consulting the EAF Workbooks. Although the EAF Mapper provides the most up-to-date digital data available to DEC, you may also need to contact local or other data sources in order to obtain data not provided by the Mapper. Digital data is not a substitute for agency determinations.



Part 1 / Question 7 [Critical Environmental Area]	No
Part 1 / Question 12a [National or State Register of Historic Places or State Eligible Sites]	Yes
Part 1 / Question 12b [Archeological Sites]	Yes
Part 1 / Question 13a [Wetlands or Other Regulated Waterbodies]	Yes - Digital mapping information on local and federal wetlands and waterbodies is known to be incomplete. Refer to EAF Workbook.
Part 1 / Question 15 [Threatened or Endangered Animal]	Yes
Part 1 / Question 15 [Threatened or Endangered Animal - Name]	Green Floater, Bald Eagle
Part 1 / Question 16 [100 Year Flood Plain]	Digital mapping data are not available or are incomplete. Refer to EAF Workbook.
Part 1 / Question 20 [Remediation Site]	No